

ADDENDUM #2

Date: December 17, 2019

This Addendum applicable to work designated herein shall be understood to be and is an Addendum and as such shall be part of and included in the Contract.

To all bidders for furnishing all labor and materials necessary for:

**KENWORTH SALES COMPANY, INC.
OGDEN, UTAH, NBW#16066**

Failure to acknowledge receipt of this Addendum on the bid proposal form may result in rejection of your bid.

Addendum consists of: 1 page. Attached Documents consist of – Sheet C000, Sheet C100, Sheet C101, Sheet C102, Sheet C201, Sheet C202, Sheet C301, Sheet C302, Sheet C501

CIVIL ITEMS

1. Sheet C000 – Demolition Plan - Demolition Limit Line adjusted to include parking lot expansion into existing asphalt to the north.
2. Sheet C100 – Site Plan – Indicated percentage of hardscape and landscape.
3. Sheet C101 & Sheet C102 – Site Plan - Moved parking stalls, curb and gutter and fencing on North side of new building, north approximately 10-feet. Removed paint strip hatching from west side of south entrance gate.
4. Sheet C201 & Sheet C202 – Grading and Drainage Plan - Regrading parking stalls and drive area north of the new building to accommodate the parking lot layout change. Added grades and slopes in the Gravel Truck Parking area on the north side of the site. Added berm adjacent to the west side of the detention pond in the northeast corner of the site.
5. Sheet C301 & Sheet C302 – Utility Plan - Added piping to connect roof drains. Adjusted Inlet box location in area where parking stalls were revised. Added a 5-foot diameter Sump at northwest corner of graveled truck parking area.
6. Sheet C501 – Detail Sheet – Added a detail for a 5-foot diameter Sump.

END OF ADDENDUM NO.2



Scott L. Nielson, A.I.A. Kevin R. Bodily, A.I.A. James H. Wyatt, A.I.A.
Members of the American Institute of Architects

Page 1

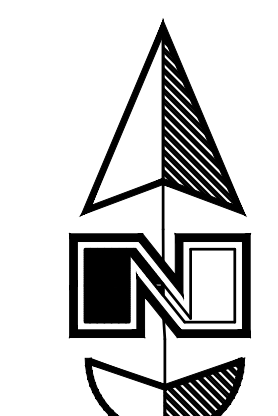


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A NEW BUILDING FOR:
KENWORTH SALES COMPANY INC.
 1750 SOUTH 1350 WEST
 WEST HAVEN, UTAH
 DEMOLITION PLAN

PROJECT:
 REVISIONS
 2 ADDENDUM 2
 PROJECT NO.
 16066
 DATE:
 NOVEMBER 2019
 DRAWN BY:
 BN
 CHECKED BY:
 MB

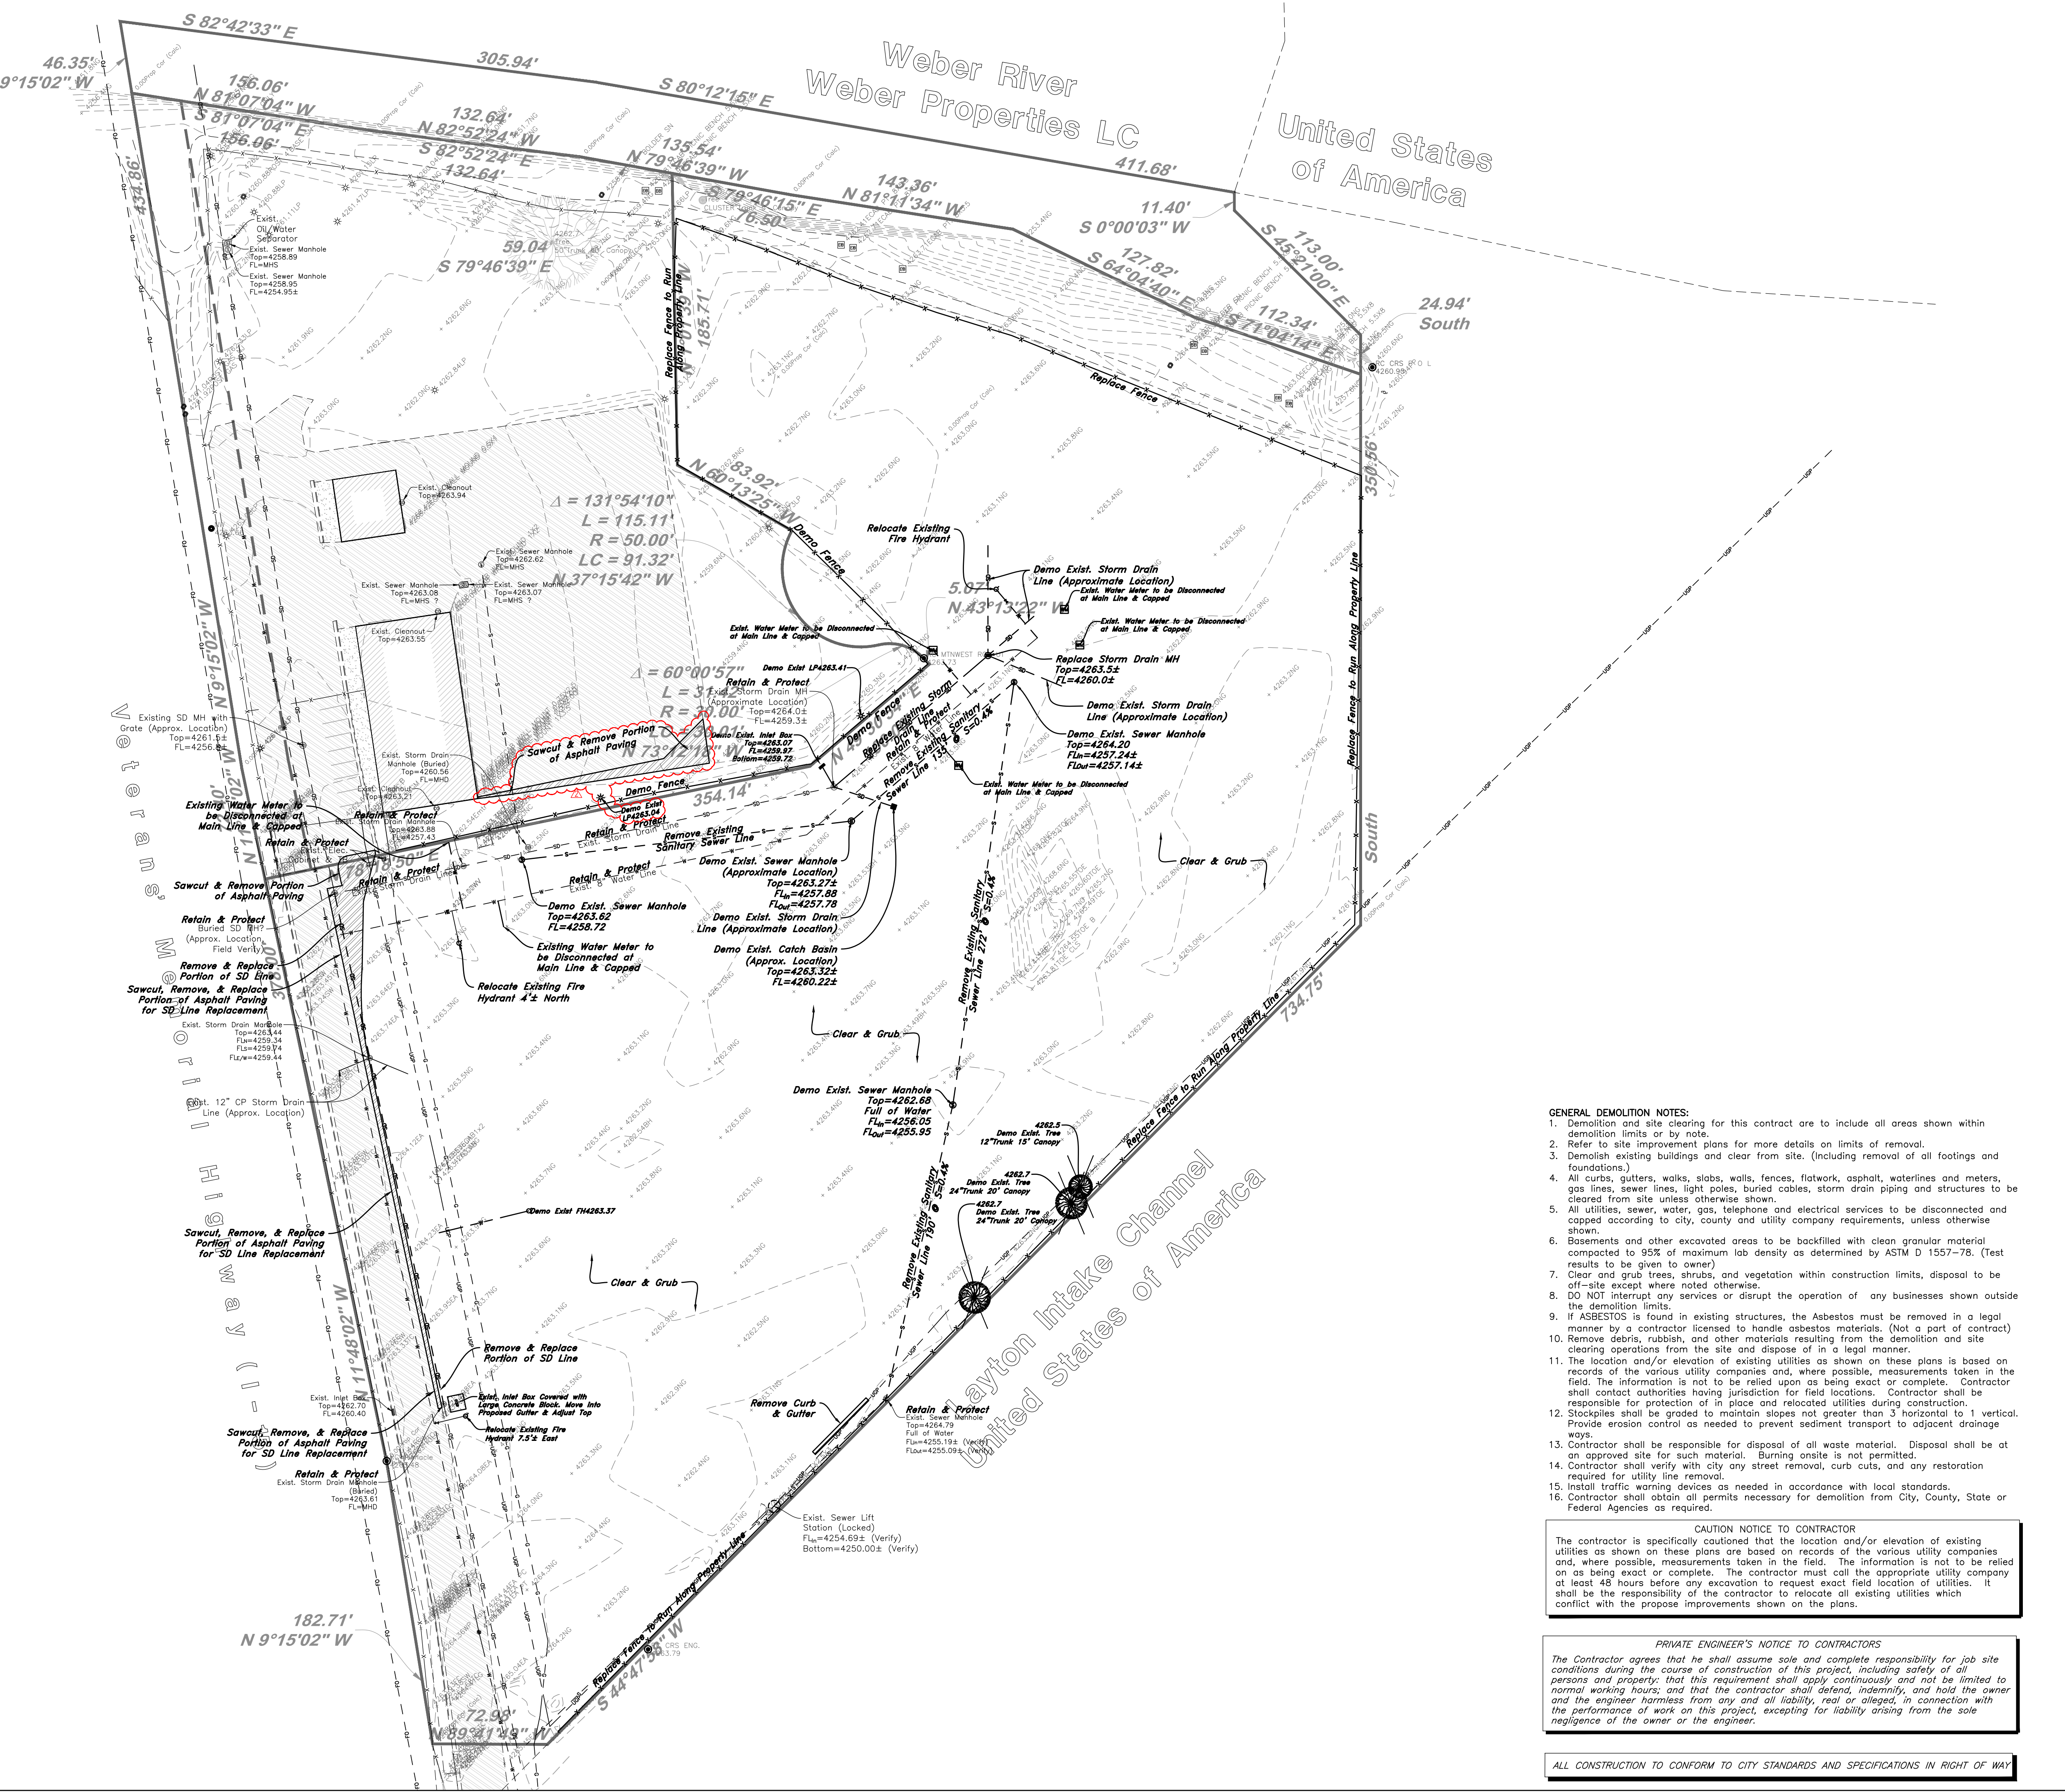
DRAWING NO.: **AD #2**
C000
 REVISED 12-17-19



Scale: 1" = 50'
 Graphic Scale

Legend
 (Note: All items may not appear on drawing)

- San. Sewer Manhole
- Water Manhole
- Storm Drain Manhole
- Cleanout
- Electrical Manhole
- Catch Basins
- Exist. Fire Hydrant
- Fire Hydrant
- Fire Department Connection
- Post Indicator Valve
- Exist. Water Valve
- Sanitary Sewer
- Culinary Water
- Gas Line
- Irrigation Line
- Storm Drain
- Telephone Line
- Secondary Waterline
- Power Line
- Fire Line
- Land Drain
- Power pole
- Power pole w/guy
- Light Pole
- Fence
- Flowline of ditch
- Overhead Power line
- Corrugated Metal Pipe
- Concrete Pipe
- Reinforced Concrete Pipe
- Ductile Iron
- Polyvinyl Chloride
- Top of Asphalt
- Edge of Asphalt
- Centerline
- Flowline
- Finish Floor
- FT
- TC
- TW
- TW
- Top of Wall
- Top of Walk
- TON
- Top of Concrete
- Natural Ground
- FG
- ME
- Match Existing
- Fire Department Connection
- FDC
- 30'
- Exist. Contour
- Finish Grade
- 95.531A
- 95.721A
- Exist. Grade
- Ridge Line
- Direction of Flow
- Existing Asphalt
- New Asphalt
- Heavy Duty Asphalt
- Existing Concrete
- New Concrete
- Demo'd Road Base
- Spill Curb & Gutter
- Demo Tree
- Tree To Remain in Place



- GENERAL DEMOLITION NOTES:**
- Demolition and site clearing for this contract are to include all areas shown within demolition limits or by note.
 - Refer to site improvement plans for more details on limits of removal.
 - Demolish existing buildings and clear from site. (Including removal of all footings and foundations.)
 - All curbs, gutters, walks, slabs, walls, fences, flatwork, asphalt, waterlines and meters, gas lines, sewer lines, light poles, buried cables, storm drain piping and structures to be cleared from site unless otherwise shown.
 - All utilities, sewer, water, gas, telephone and electrical services to be disconnected and capped according to city, county and utility company requirements, unless otherwise shown.
 - Basements and other excavated areas to be backfilled with clean granular material compacted to 95% of maximum lab density as determined by ASTM D 1557-78. (Test results to be given to owner)
 - Clear and grub trees, shrubs, and vegetation within construction limits, disposal to be off-site except where noted otherwise.
 - DO NOT interrupt any services or disrupt the operation of any businesses shown outside the demolition limits.
 - If ASBESTOS is found in existing structures, the Asbestos must be removed in a legal manner by a contractor licensed to handle asbestos materials. (Not a part of contract)
 - Remove debris, rubbish, and other materials resulting from the demolition and site clearing operations from the site and dispose of in a legal manner.
 - The location and/or elevation of existing utilities as shown on these plans is based on records of the various utility companies and, where possible, measurements taken in the field. The information is not to be relied upon as being exact or complete. Contractor shall contact authorities having jurisdiction for field locations. Contractor shall be responsible for protection of in place and relocated utilities during construction.
 - Stackpiles shall be graded to maintain slopes not greater than 3 horizontal to 1 vertical. Provide erosion control as needed to prevent sediment transport to adjacent drainage ways.
 - Contractor shall be responsible for disposal of all waste material. Disposal shall be at an approved site for such material. Burning onsite is not permitted.
 - Contractor shall verify with city any street removal, curb cuts, and any restoration required for utility line removal.
 - Install traffic warning devices as needed in accordance with local standards.
 - Contractor shall obtain all permits necessary for demolition from City, County, State or Federal Agencies as required.

CAUTION NOTICE TO CONTRACTOR
 The contractor is specifically cautioned that the location and/or elevation of existing utilities as shown on these plans are based on records of the various utility companies and, where possible, measurements taken in the field. The information is not to be relied upon as being exact or complete. The contractor must call the appropriate utility company at least 48 hours before any excavation to request exact field location of utilities. It shall be the responsibility of the contractor to relocate all existing utilities which conflict with the proposed improvements shown on the plans.

PRIVATE ENGINEER'S NOTICE TO CONTRACTORS
 The Contractor agrees that he shall assume sole and complete responsibility for job site conditions during the course of construction of this project, including safety of all persons and property; that this requirement shall apply continuously and not be limited to normal working hours; and that the contractor shall defend, indemnify, and hold the owner and the engineer harmless from any and all liability, real or alleged, in connection with the performance of work on this project, excepting for liability arising from the sole negligence of the owner or the engineer.

ALL CONSTRUCTION TO CONFORM TO CITY STANDARDS AND SPECIFICATIONS IN RIGHT OF WAY



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A NEW BUILDING FOR:
KENWORTH SALES COMPANY INC.
 1750 SOUTH 1350 WEST
 WEST HAVEN, UTAH
 OVERALL SITE PLAN

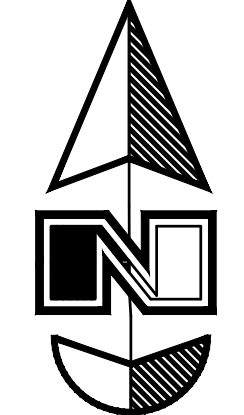
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 SHEET TITLE:

REVISIONS	
2	ADDENDUM 2

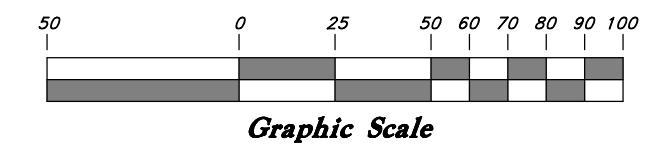
PROJECT NO.
 16066
 DATE:
 NOVEMBER 2019
 DRAWN BY:
 BN
 CHECKED BY:
 MB

DRAWING NO.: **AD #2**

C100
 REVISED 12-17-19

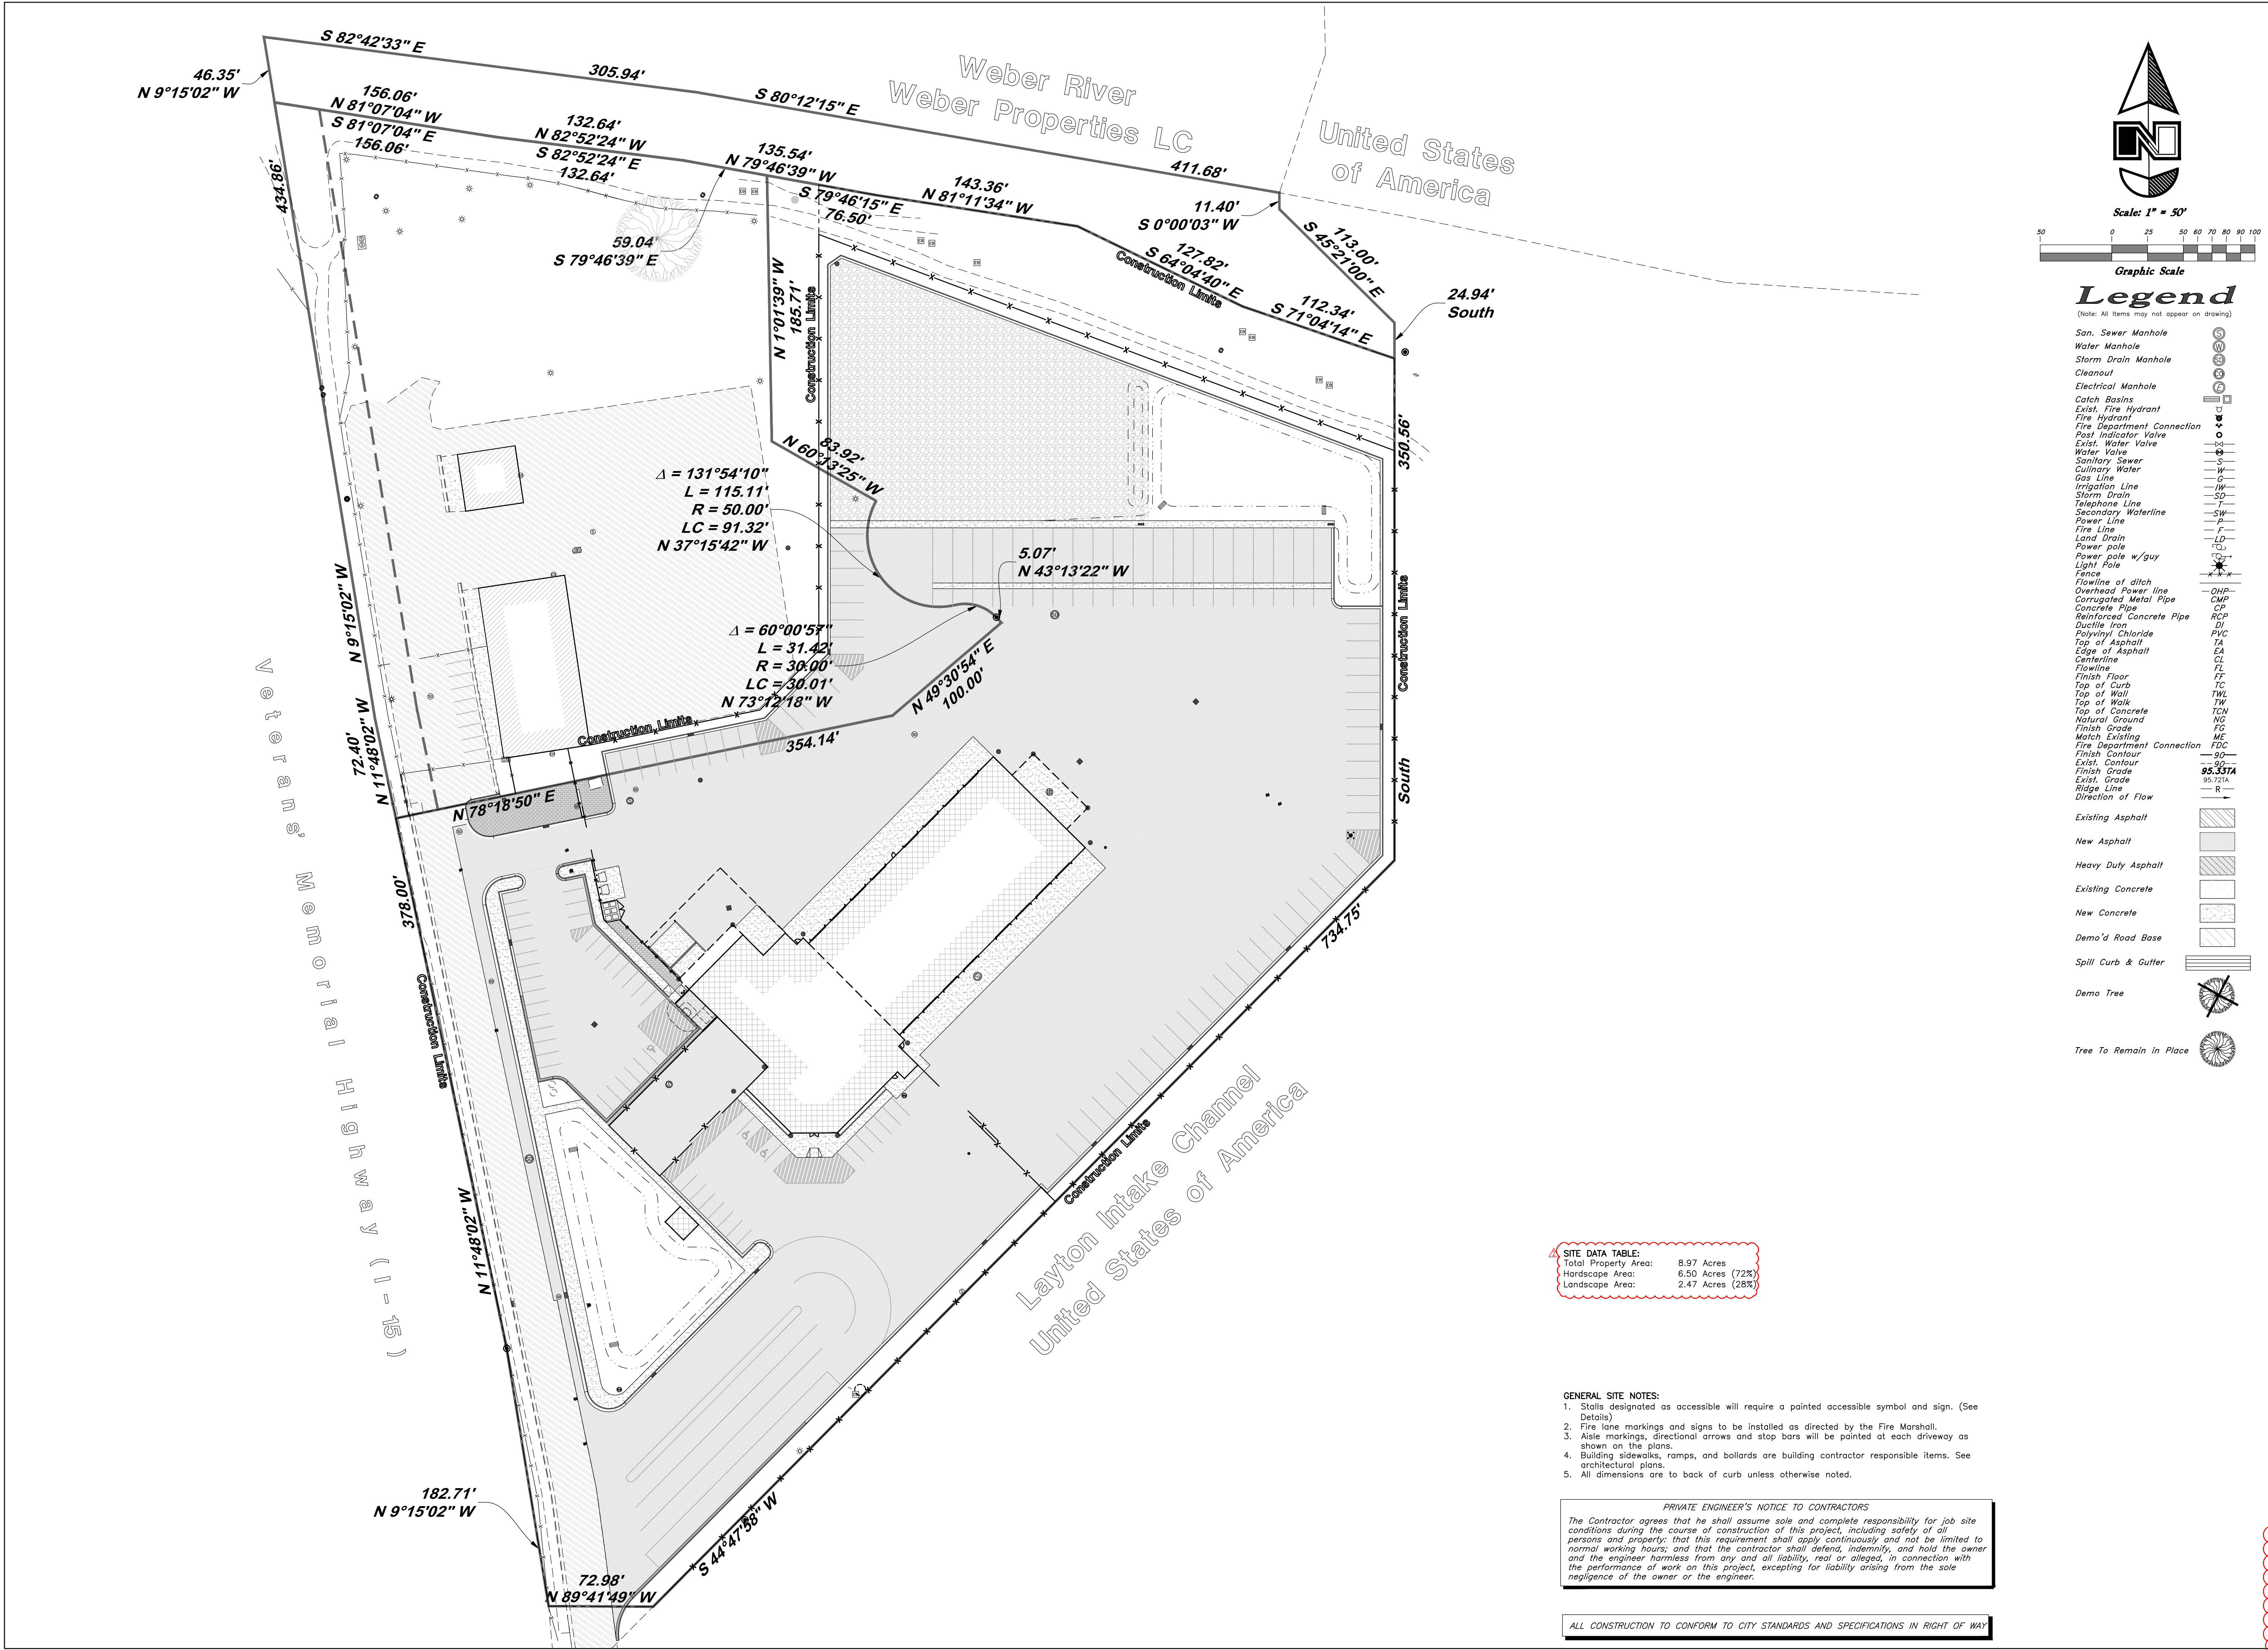


Scale: 1" = 50'



Legend
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- San. Sewer Manhole
- Water Manhole
- Storm Drain Manhole
- Cleanout
- Electrical Manhole
- Catch Basins
- Exist. Fire Hydrant
- Fire Hydrant
- Fire Department Connection
- Post Indicator Valve
- Exist. Water Valve
- Water Valve
- Sanitary Sewer
- Culinary Water
- Gas Line
- Irrigation Line
- Storm Drain
- Telephone Line
- Secondary Waterline
- Power Line
- Fire Line
- Land Drain
- Power pole w/guy
- Light Pole
- Fence
- Flowline of ditch
- Overhead Power line
- Corrugated Metal Pipe
- Concrete Pipe
- Reinforced Concrete Pipe
- Ductile Iron
- Polyvinyl Chloride
- Top of Asphalt
- Edge of Asphalt
- Centerline
- Flowline
- Finish Floor
- Top of Curb
- Top of Wall
- Top of Walk
- Top of Concrete
- Natural Ground
- Finish Grade
- Match Existing
- Fire Department Connection
- Finish Contour
- Exist. Contour
- Finish Grade
- Exist. Grade
- Ridge Line
- Direction of Flow
- Existing Asphalt
- New Asphalt
- Heavy Duty Asphalt
- Existing Concrete
- New Concrete
- Demo'd Road Base
- Spill Curb & Gutter
- Demo Tree
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SITE DATA TABLE:

Total Property Area:	8.97 Acres
Hardscape Area:	6.50 Acres (72%)
Landscape Area:	2.47 Acres (28%)

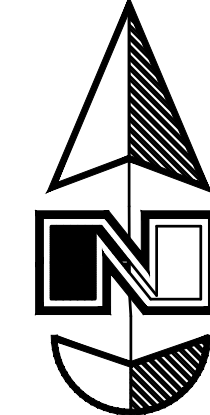
- GENERAL SITE NOTES:**
1. Stalls designated as accessible will require a painted accessible symbol and sign. (See Details)
 2. Fire lane markings and signs to be installed as directed by the Fire Marshall.
 3. Aisle markings, directional arrows and stop bars will be painted at each driveway as shown on the plans.
 4. Building sidewalks, ramps, and bollards are building contractor responsible items. See architectural plans.
 5. All dimensions are to back of curb unless otherwise noted.

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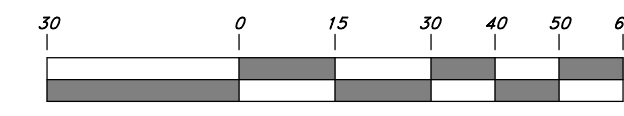
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Weber Properties LC

United States of America



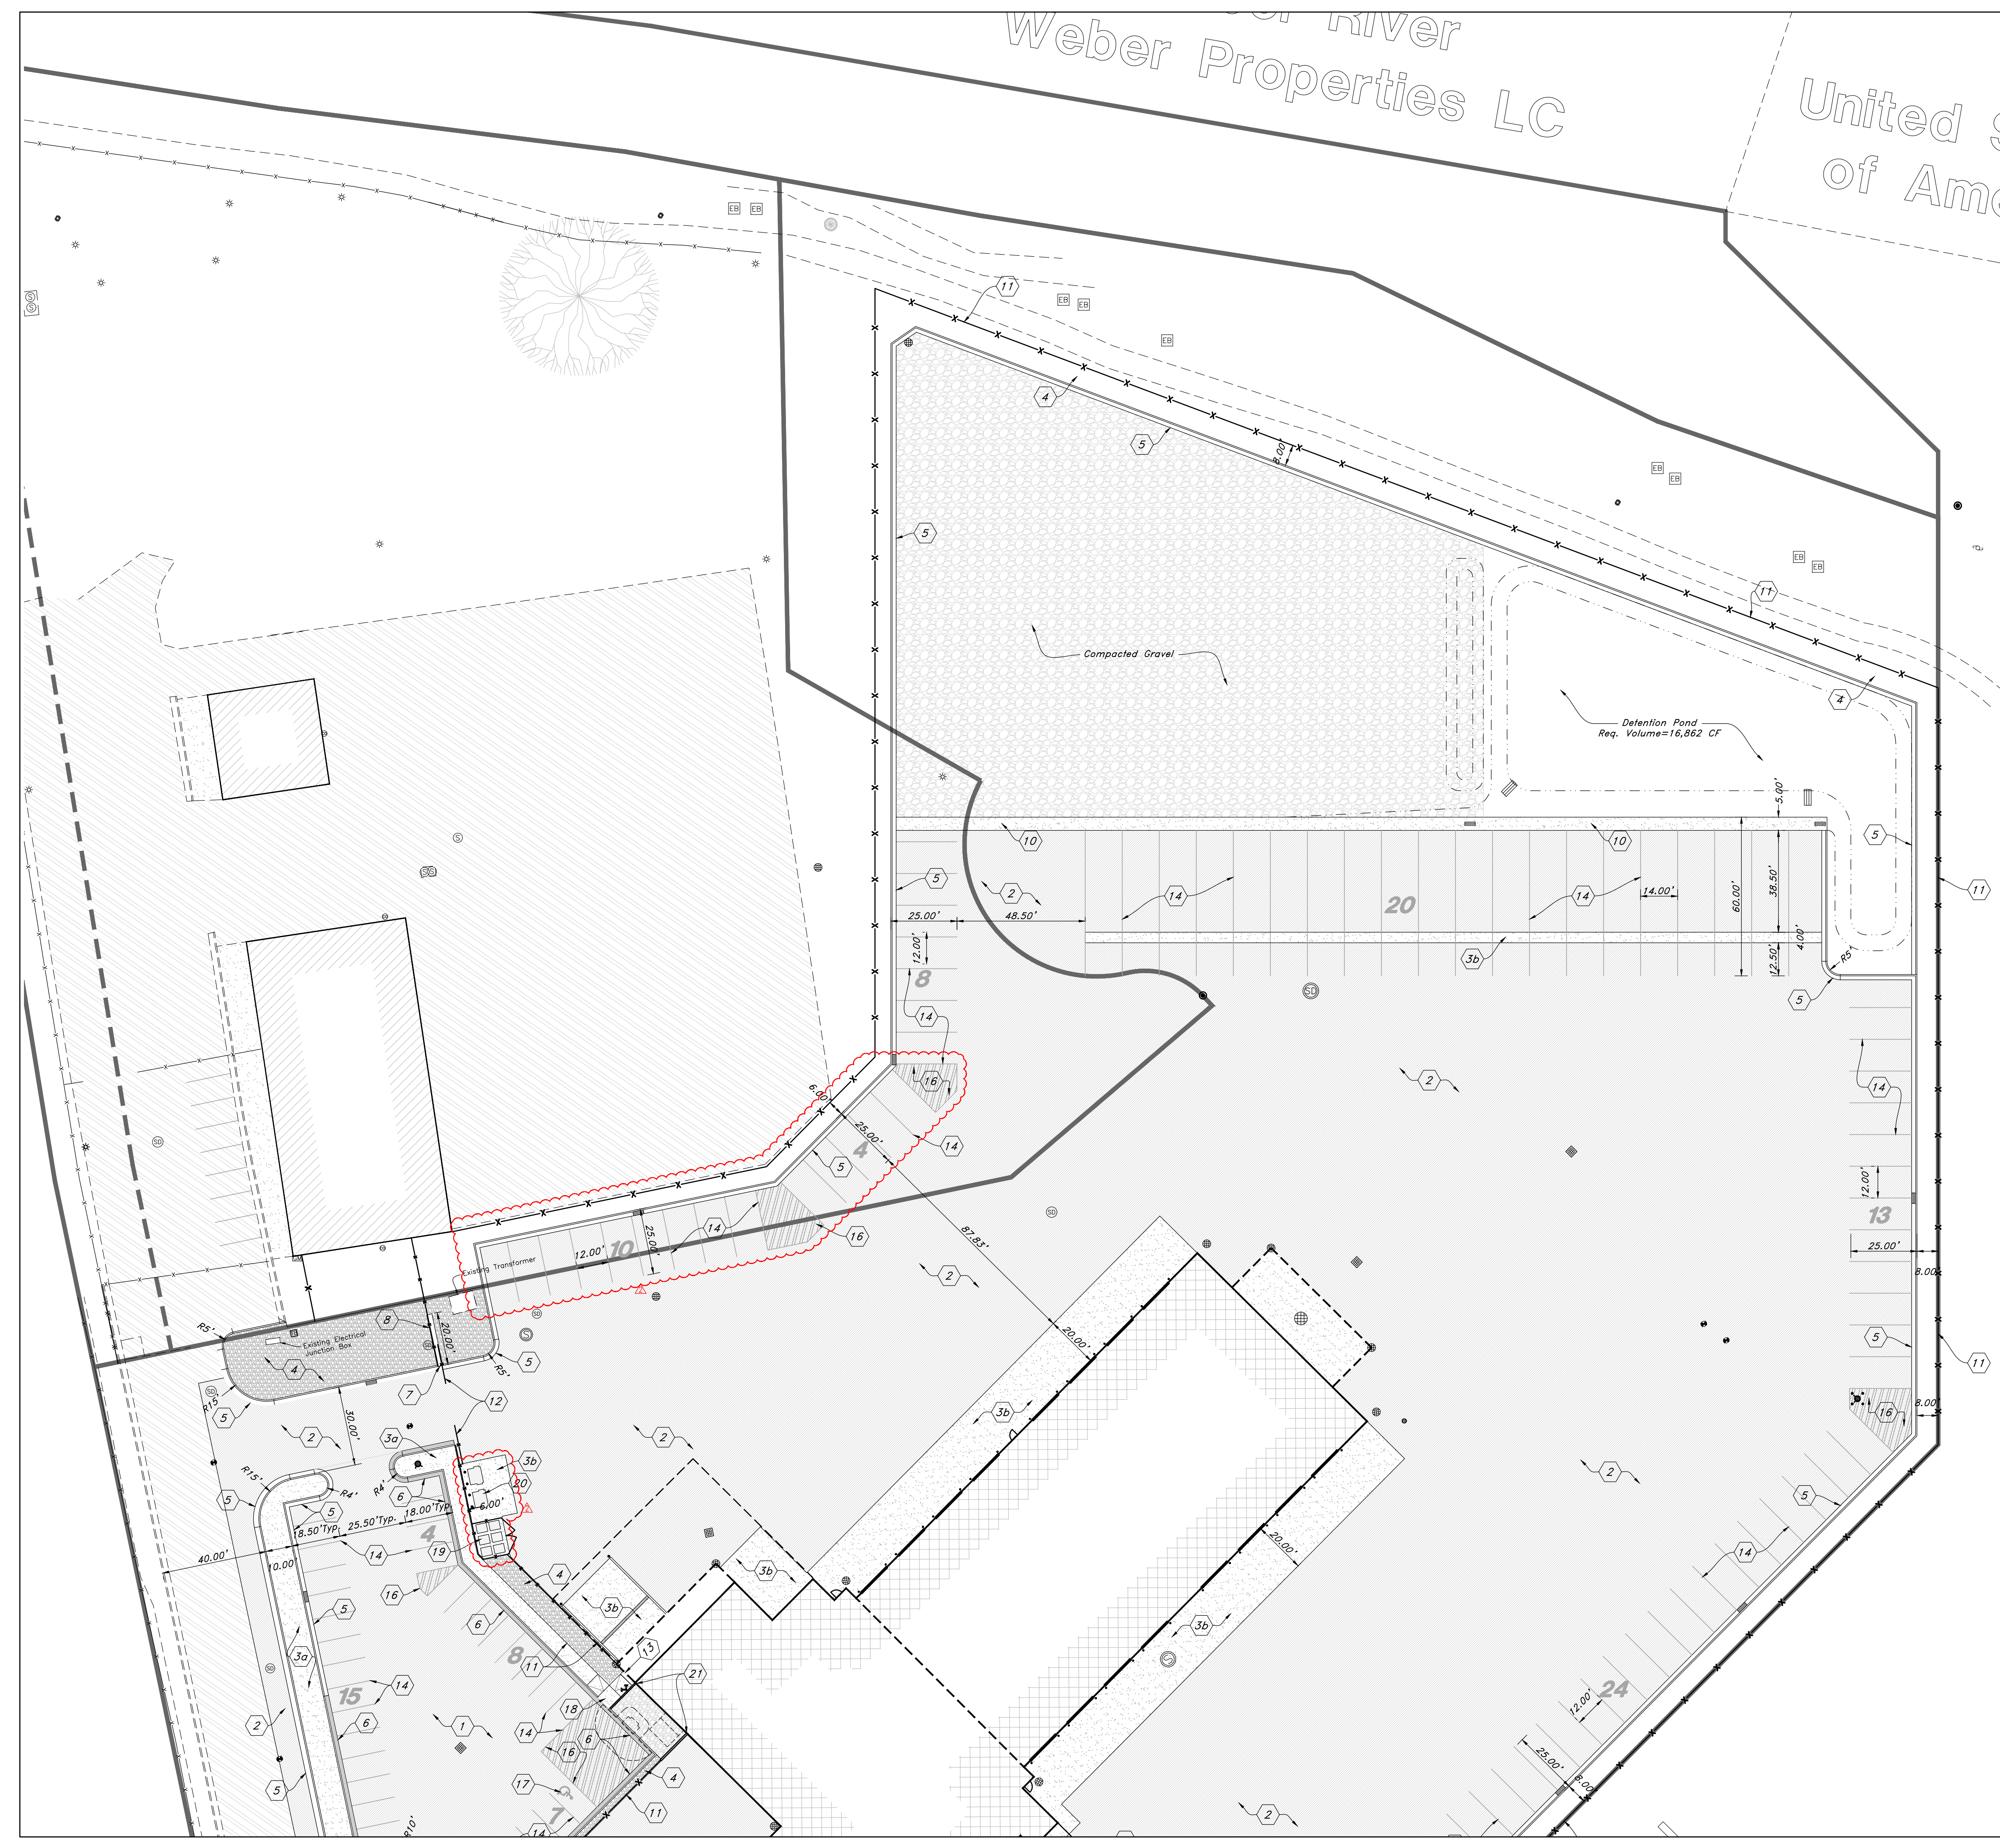
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Legend

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- Fire Line
- Land Drain
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- Light Pole
- Fence
- Flowline of ditch
- Overhead Power line
- Corrugated Metal Pipe
- Concrete Pipe
- Reinforced Concrete Pipe
- Ductile Iron
- Polyvinyl Chloride
- Top of Asphalt
- Edge of Asphalt
- Centerline
- Flowline
- Finish Floor
- Top of Curb
- Top of Wall
- Top of Walk
- Top of Concrete
- Natural Ground
- Finish Grade
- Match Existing
- Fire Department Connection
- Finish Contour
- Exist. Contour
- Finish Grade
- Exist. Grade
- Ridge Line
- Direction of Flow
- Existing Asphalt
- New Asphalt
- Heavy Duty Asphalt
- Existing Concrete
- New Concrete
- Demo'd Road Base
- Spill Curb & Gutter
- Demo Tree
- Tree To Remain In Place



Note	Detail Reference
1 Construct Standard Asphalt Paving	See Detail 3/C500
2 Construct Heavy Duty Asphalt Paving	See Detail 2/C500
3 Construct Concrete Paving	See Detail 4/C500
a) Thickness = 4"	
b) Thickness = 6"	
4 Rock Mulch	See Architectural Plans
5 Construct 24" Standard Curb & Gutter	See Detail 8/C500
6 Construct 24" Spill Curb & Gutter	See Detail 8/C500
7 Curb Cut	See Architectural Plans
8 Construct 24" Mowstrip	See Architectural Plans
9 Construct Thickened Edge Walk	See Detail 13/C500
10 Construct 5.0' Waterway	See Detail 12/C500
11 Construct 10' Tall Chainlink Fence w/ 2' Barbed Wire	See Architectural Plans
12 Construct Sliding Gate	See Architectural Plans
13 Construct Man Gate	See Architectural Plans
14 Construct Striping	See Detail 10/C500
15 Construct Crosswalk Striping	See Detail 7/C500
16 Construct "No Parking" Striping	See Detail 7/C500
17 Construct ADA Striping	See Detail 6/C500
18 Construct ADA Ramp	See Detail 11/C500
19 Core Storage Area	See Architectural Plans
20 Dumpster Area, Enclosed by Screen Wall	See Architectural Plans
21 Construct Screen Wall	See Architectural Plans
22 Smoke Shelter	See Architectural Plans

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A NEW BUILDING FOR:
KENWORTH SALES COMPANY INC.
 1750 SOUTH 1350 WEST
 WEST HAVEN, UTAH
 SHEET TITLE: SITE PLAN 'A'

PROJECT: KENWORTH SALES COMPANY INC.

REVISIONS	DATE	DESCRIPTION
2		ADDENDUM 2

PROJECT NO. 16066
 DATE: NOVEMBER 2019
 DRAWN BY: BN
 CHECKED BY: MB

DRAWING NO.: **C101** AD #2
 REVISED 12-17-19



Veterans' Memorial Highway (1-15)

Scale: 1" = 30'

Graphic Legend

(Note: All items may not appear on drawing)

- San. Sewer Manhole
- Water Manhole
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- Cleanout
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- Exist. Fire Hydrant
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- Secondary Waterline
- Power Line
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- Land Drain
- Power pole
- Power pole w/guy
- Light Pole
- Fence
- Flowline of ditch
- Overhead Power line
- Corrugated Metal Pipe
- Concrete Pipe
- Reinforced Concrete Pipe
- Ductile Iron
- Polyvinyl Chloride
- Top of Asphalt
- Edge of Asphalt
- Centerline
- Flowline
- Finish Floor
- Top of Curb
- Top of Wall
- Top of Walk
- Top of Concrete
- Natural Ground
- Finish Grade
- Match Existing
- Fire Department Connection
- Finish Contour
- Exist. Contour
- Finish Grade
- Exist. Grade
- Ridge Line
- Direction of Flow

- Existing Asphalt
- New Asphalt
- Heavy Duty Asphalt
- Existing Concrete
- New Concrete
- Demo'd Road Base
- Spill Curb & Gutter
- Demo Tree
- Tree To Remain in Place

Note	Detail Reference
1 Construct Standard Asphalt Paving	See Detail 3/C500
2 Construct Heavy Duty Asphalt Paving	See Detail 2/C500
3 Construct Concrete Paving	See Detail 4/C500
a) Thickness = 4"	
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4 Rock Mulch	See Architectural Plans
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9 Construct Thickened Edge Walk	See Detail 13/C500
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11 Construct 10' Tall Chainlink Fence w/ 2' Barbed Wire	See Architectural Plans
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13 Construct Man Gate	See Architectural Plans
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15 Construct Crosswalk Striping	See Detail 7/C500
16 Construct "No Parking" Striping	See Detail 7/C500
17 Construct ADA Striping	See Detail 6/C500
18 Construct ADA Ramp	See Detail 11/C500
19 Core Storage Area	See Architectural Plans
20 Dumpster Area, Enclosed by Screen Wall	See Architectural Plans
21 Construct Screen Wall	See Architectural Plans
22 Smoke Shelter	See Architectural Plans

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A NEW BUILDING FOR:
KENWORTH SALES COMPANY INC.
1750 SOUTH 1350 WEST
WEST HAVEN, UTAH

PROJECT:
SHEET TITLE: SITE PLAN 'B'

REVISIONS
2 ADDENDUM 2

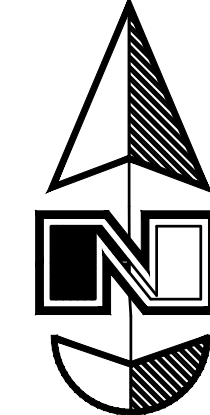
PROJECT NO.
16066
DATE:
NOVEMBER 2019
DRAWN BY:
BN
CHECKED BY:
MB

DRAWING NO.: **C102** AD #2
REVISED 12-17-19

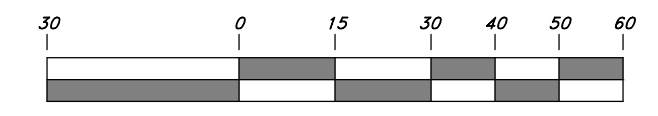
Weber Properties LC

United States of America

Veterans' Memorial



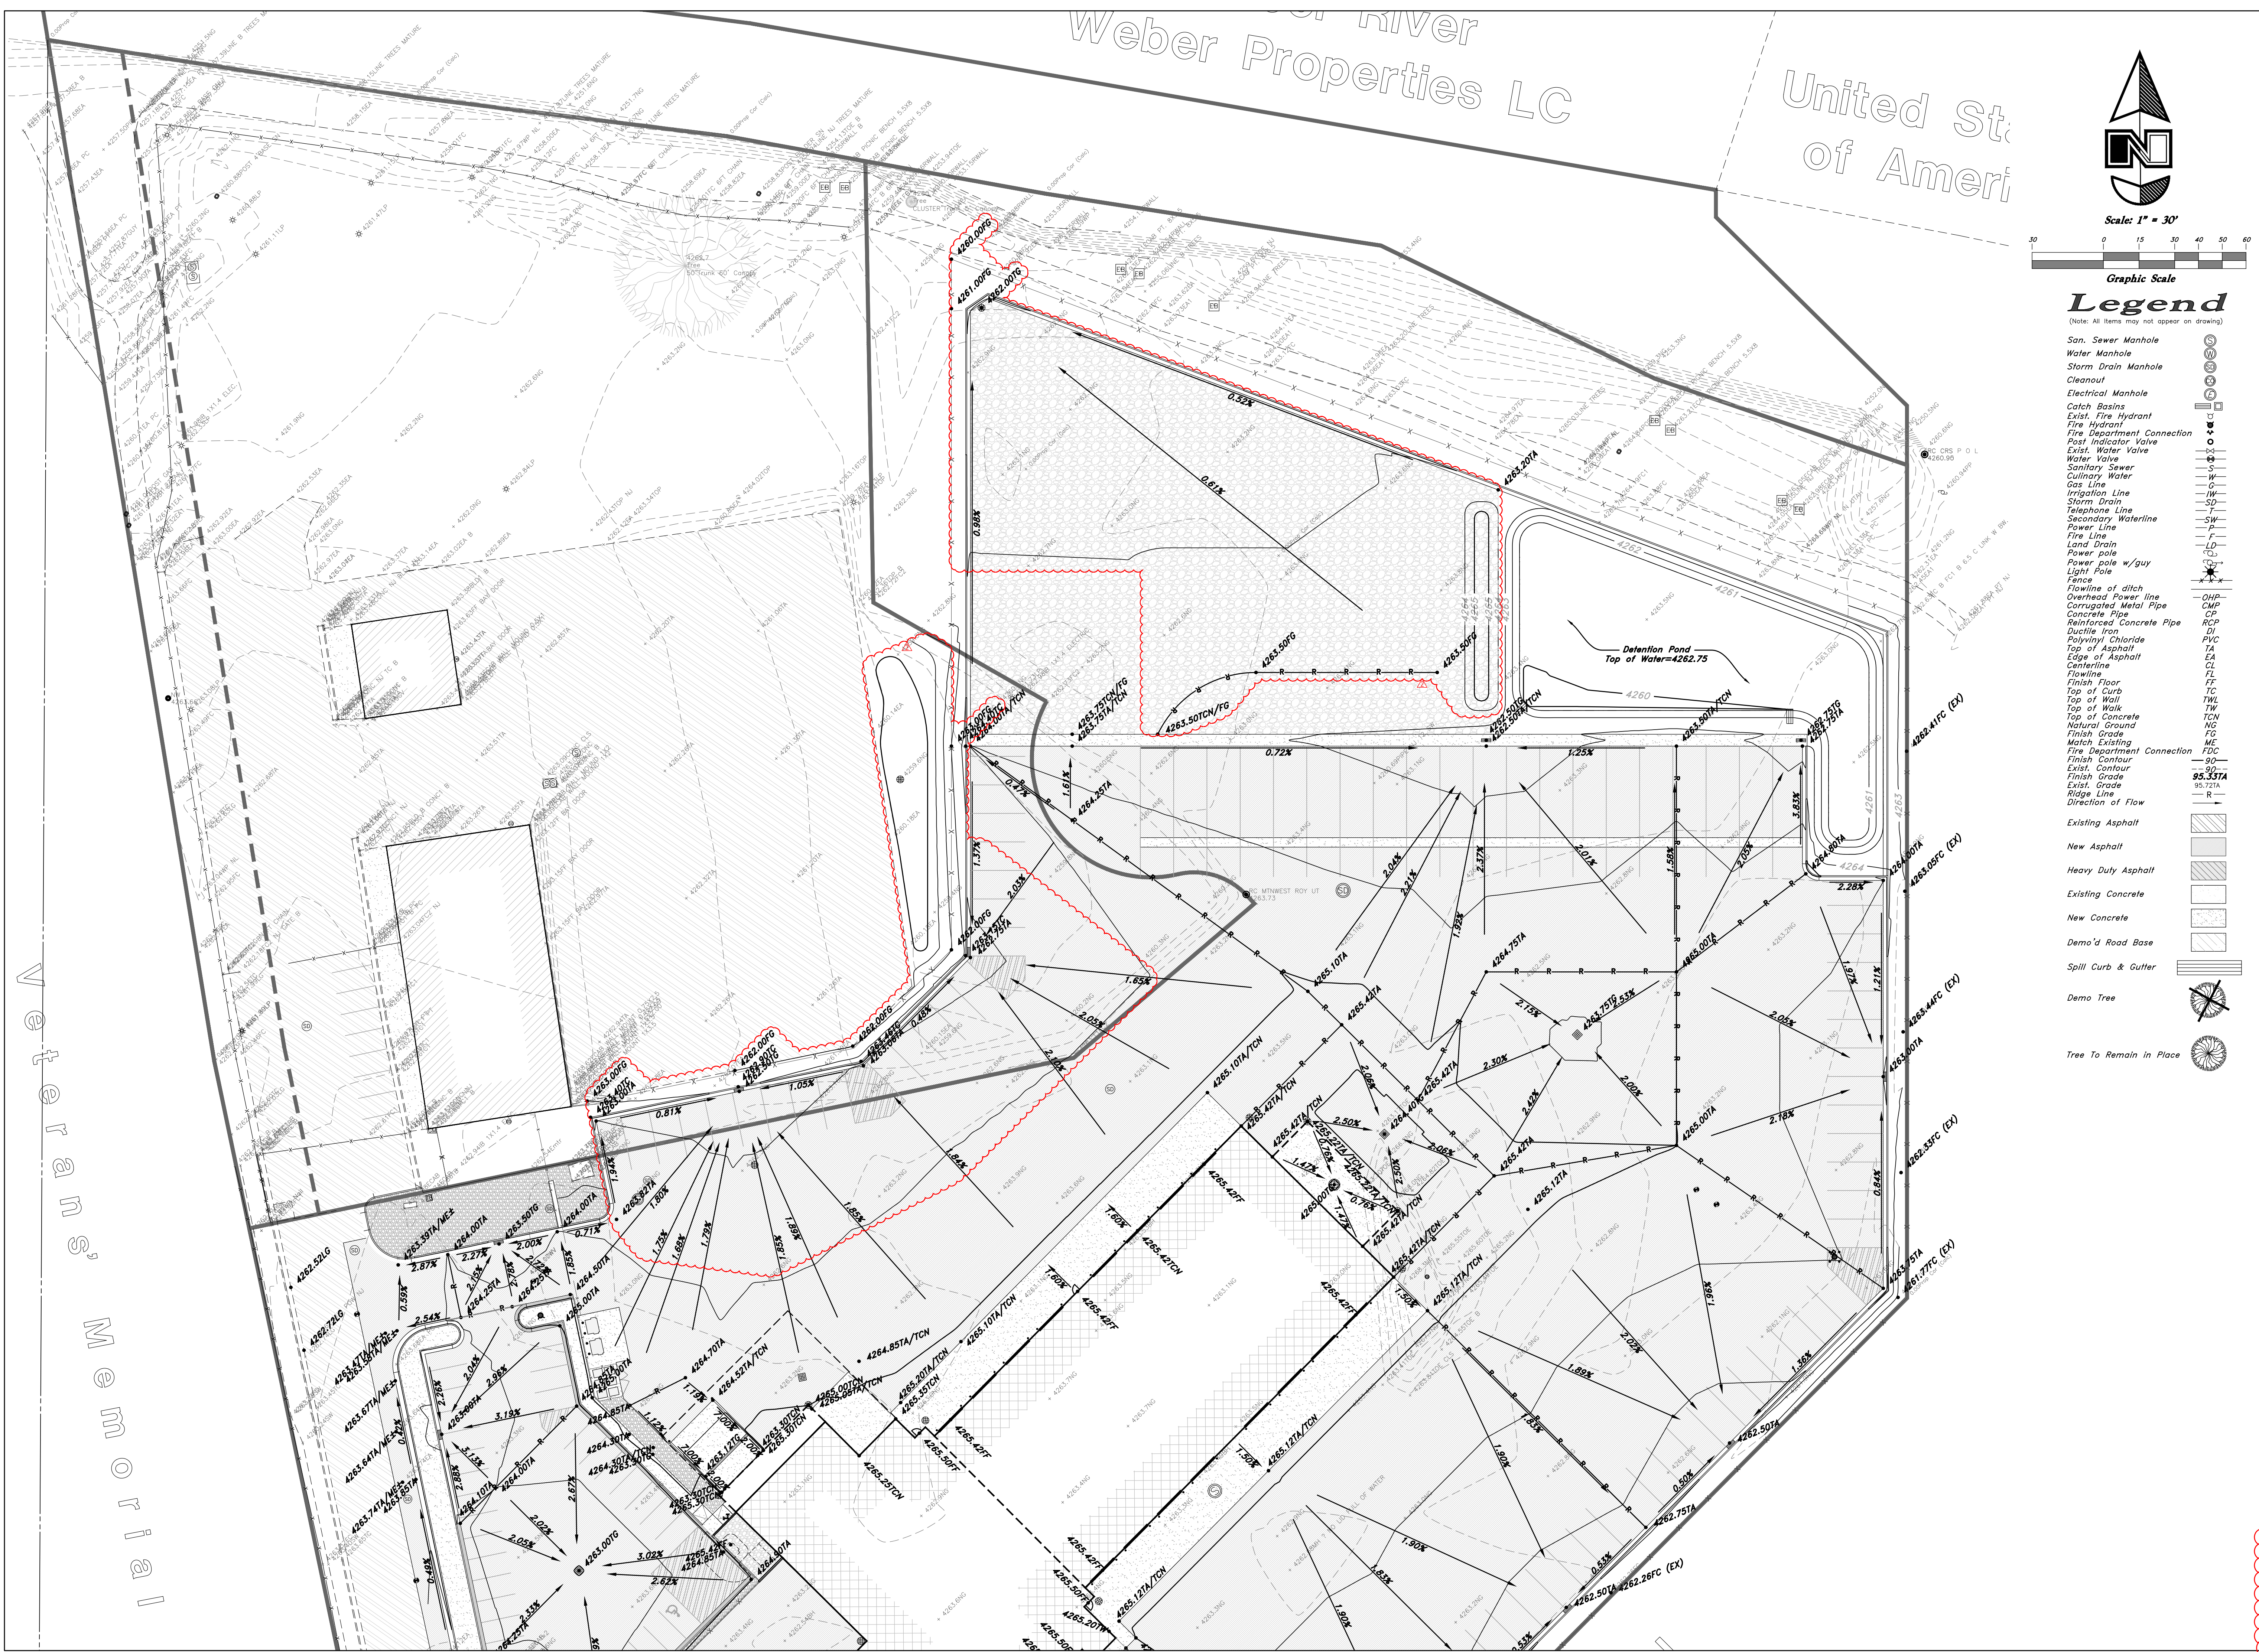
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Legend

(Note: All items may not appear on drawing)

- San. Sewer Manhole
 - Water Manhole
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 - Centerline
 - Flowline
 - Finish Floor
 - FT
 - TC
 - Top of Wall
 - TW
 - Top of Walk
 - TCN
 - Top of Concrete
 - Natural Ground
 - NG
 - FG
 - Finish Grade
 - ME
 - Match Existing
 - Fire Department Connection
 - FDC
 - 90'
 - Exist. Contour
 - 95.53TA
 - Finish Contour
 - 95.72TA
 - Exist. Grade
 - R
 - Direction of Flow
- Existing Asphalt
 - New Asphalt
 - Heavy Duty Asphalt
 - Existing Concrete
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A NEW BUILDING FOR:
KENWORTH SALES COMPANY INC.
 1750 SOUTH 1350 WEST
 WEST HAVEN, UTAH

PROJECT:
 SHEET TITLE: GRADING PLAN 'A'

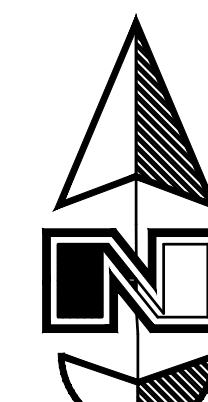
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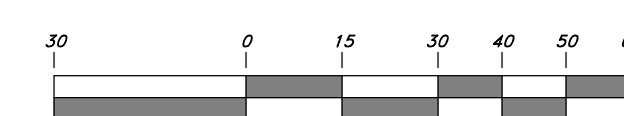
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C201
 REVISED 12-17-19

Veterans' Memorial Highway (1-15)



Scale: 1" = 30'

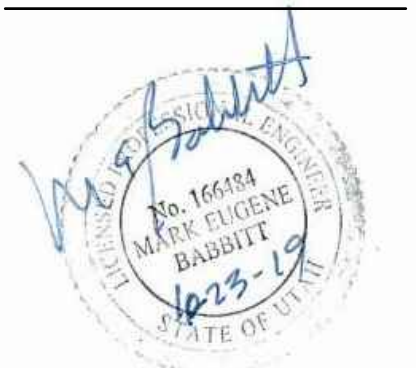


Graphic Legend

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A NEW BUILDING FOR:
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 1750 SOUTH 1350 WEST
 WEST HAVEN, UTAH
 GRADING PLAN 'B'

PROJECT:
 SHEET TITLE:

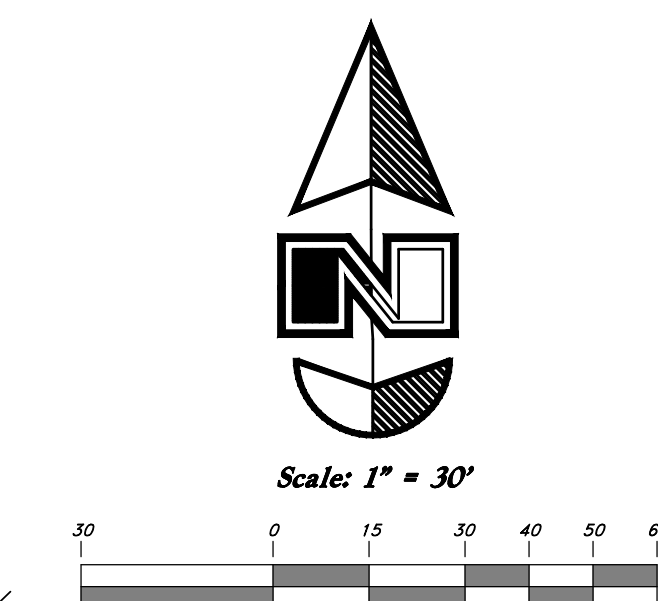
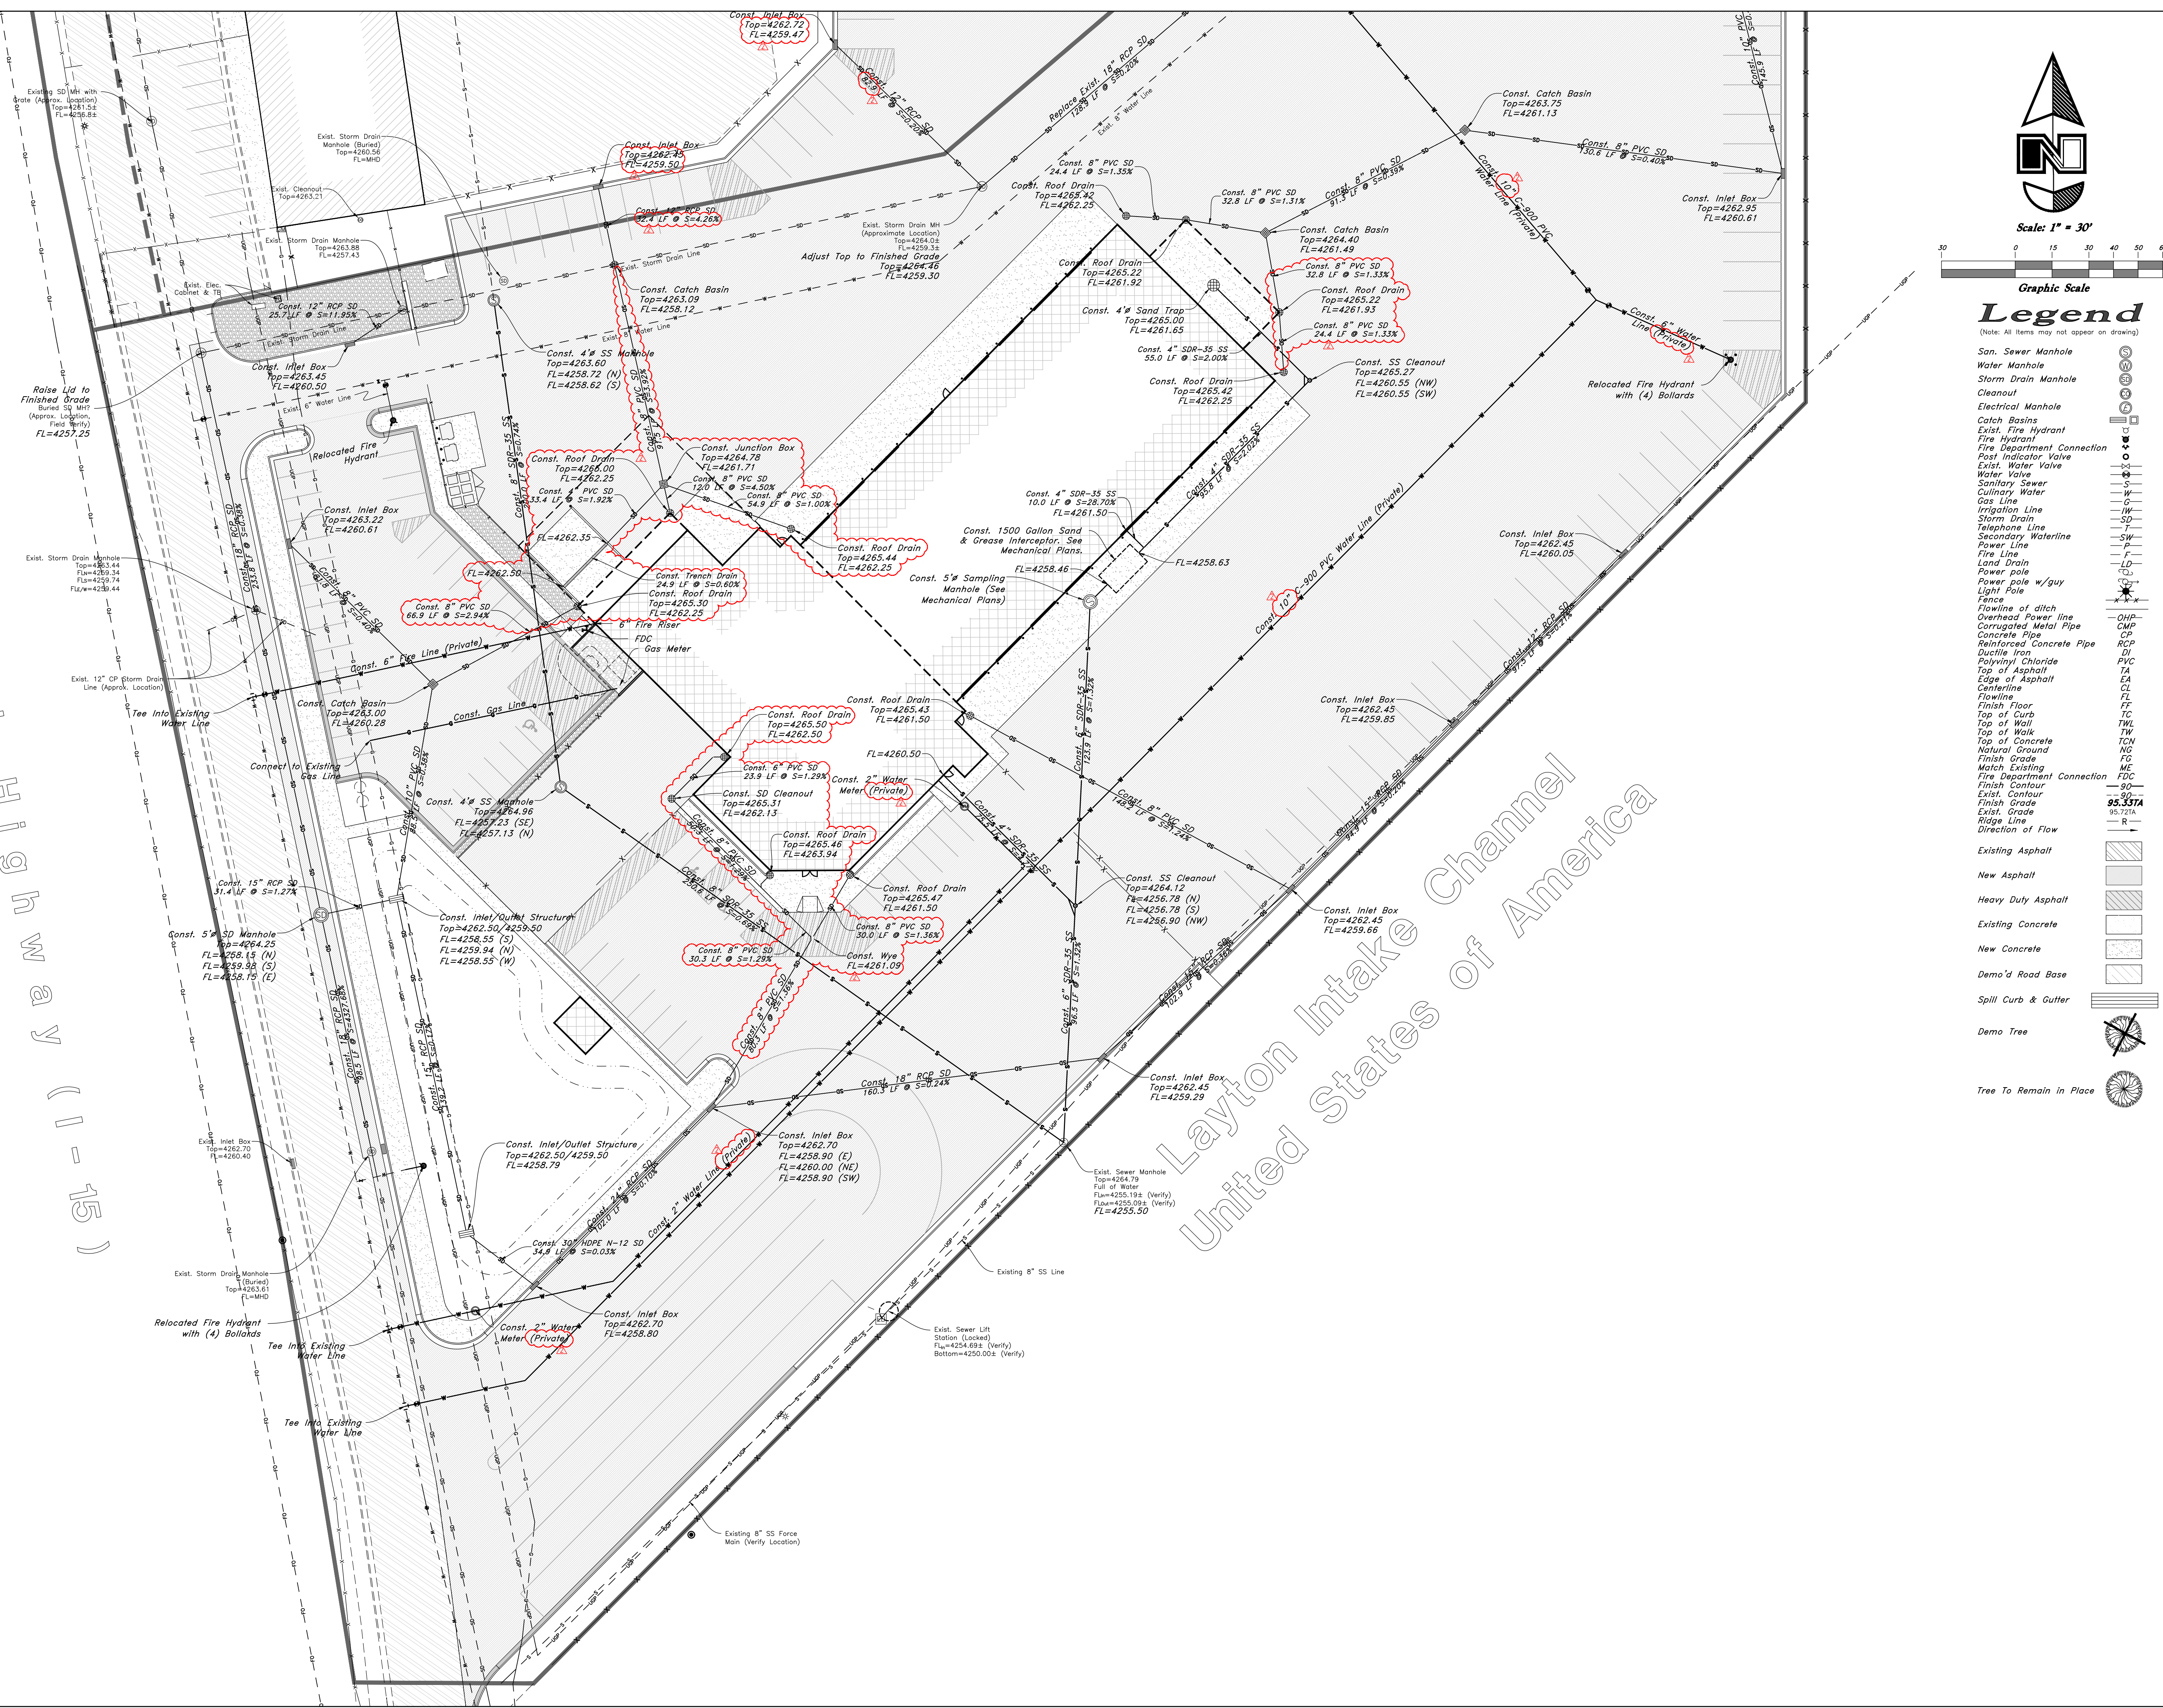
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PROJECT NO.
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DRAWING NO.: **AD #2**

C202
 REVISED 12-17-19

Veterans' Memorial Highway (I-15)



Legend
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- Flowline of ditch
- Overhead Power line
- Corrugated Metal Pipe
- Concrete Pipe
- Reinforced Concrete Pipe
- Ductile Iron
- Polyvinyl Chloride
- Top of Asphalt
- Edge of Asphalt
- Centerline
- Flowline
- Finish Floor
- FT
- TC
- Top of Wall
- TWL
- Top of Walk
- TW
- Top of Concrete
- Natural Ground
- NG
- Finish Grade
- FG
- Match Existing
- ME
- Fire Department Connection
- FDC
- Exist. Contour
- 30'
- 95.331A
- 95.721A
- Exist. Grade
- R
- Ridge Line
- Direction of Flow

Existing Asphalt

New Asphalt

Heavy Duty Asphalt

Existing Concrete

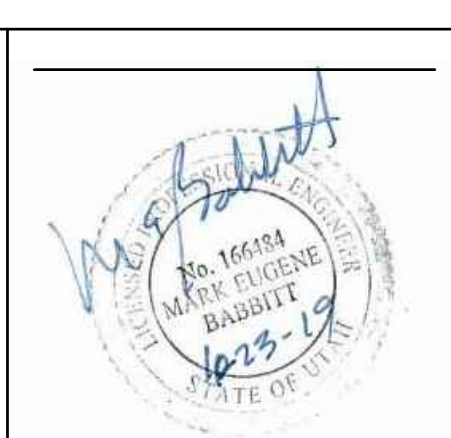
New Concrete

Demo'd Road Base

Spill Curb & Gutter

Demo Tree

Tree To Remain in Place



nw architects p.a.
ARCHITECTURE / PLANNING / INTERIORS
SCOTT L NELSON, A.I.A. KEVIN R BODILY, A.I.A. JAMES HWYATT, A.I.A.
900 JOHN ANDERSON PARKWAY, P.O. BOX 2212 - IRVING, TEXAS 75038-0212
(972) 208-5322 (972) 208-5322 (972) 208-5322 (972) 208-5322

A NEW BUILDING FOR:
KENWORTH SALES COMPANY INC.
1750 SOUTH 1350 WEST
WEST HAVEN, UTAH

UTILITY PLAN 'B'

PROJECT: 16066

DATE: NOVEMBER 2019

DRAWN BY: BN

CHECKED BY: MB

DRAWING NO.: AD #2

REVISIONS

2	ADDENDUM 2
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C302
REVISED 12-17-19



nw architects p.a.
 ARCHITECTURE / PLANNING / INTERIORS
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A NEW BUILDING FOR:
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PROJECT:
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 2 ADDENDUM 2
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C501
 REVISED 12-17-19

JUB ENGINEERS, INC.
 468 North 800 West
 Layton, Utah 84041
 Phone: 801-447-0200
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 www.jub.com

WATER SERVICE CONNECTIONS
BONA VISTA WATER IMPROVEMENT DISTRICT

STANDARD DETAIL
BV-02

JUB ENGINEERS, INC.
 468 North 800 West
 Layton, Utah 84041
 Phone: 801-447-0200
 Fax: 801-447-0201
 www.jub.com

WATER SERVICE CONNECTIONS
BONA VISTA WATER IMPROVEMENT DISTRICT

STANDARD DETAIL
BV-01

THRUST PER P.S.I. OF WATER PRESSURE AT HANGER FITTINGS

PIPE SIZE (OD x ID)	1/2" ELEV.	3/4" ELEV.	1" ELEV.	1 1/2" ELEV.
4	19	27	35	43
6	29	38	47	56
8	47	64	81	98
10	70	94	118	142
12	105	138	171	204
14	140	184	228	272
16	185	244	303	362
18	230	301	378	453
20	275	357	453	528
24	423	558	693	828

THRUST BLOCKING

NOTE: CONCRETE SHALL NOT BE PLACED WITHIN 1'-1 1/2" OF JOINTS AND BELTS. COVER ALL METAL CONTACT AREAS BEFORE POURING CONCRETE.

1. IN THE ABSENCE OF A SOIL REPORT, ALL THRUST BLOCKS SHALL BE SIZED ON THE BASIS OF A MAX. LATERAL BEARING VALUE OF 3000 P.S.F. AND A THRUST BEARING FROM PRESSURE OF THE WORKING STATIC TEST PRESSURE.

2. THRUST BLOCKS ARE NEEDED AT ALL BENDS OF 22-1/2° OR MORE.

3. CONCRETE SHALL HAVE A COMPRESSIVE STRENGTH OF NOT LESS THAN 3000 P.S.I. @ 28 DAYS.

PIPE & FITTING SCHEDULE

NO.	DESCRIPTION	UNIT
1	1" HEAVY-DUTY COMBINATION AIR-VALVE	THM
2	1/2" GATE VALVE	THM
3	1/2" SERVICE SADDLE	THM
4	1/2" BRASS STEEL PIPE	THM
5	1/2" GALV. STEEL PIPE	THM
6	1/2" GALV. STEEL PIPE	THM
7	1/2" GALV. STEEL PIPE	THM

TYPICAL MAINLINE VALVE

TYPICAL WATERLINE LOOP

TYPICAL URBAN FIRE HYDRANT CONNECTION

TYPICAL TRENCH SECTION

TYPICAL MAINLINE VALVE

COMBINATION AIR RELEASE VALVE STATION

TYPICAL URBAN FIRE HYDRANT CONNECTION

TYPICAL TRENCH SECTION

7 Not to Scale

5 Typical Catch Basin
 Not to Scale

Plan
 Section

Fabricate Cast Iron Grate (catch basin)
 Fabricate Cover (junction box)

Concrete Collar all around (catch basin)

1/4" Lip

asphalt

anchor (4 req'd)

Reinforce Box with #4 bars @ 12" O.C. both directions at center of walls and floor.

6 Typical Sump Detail
 Not to Scale

SECTION

24" Solid Manhole Ring and Cover
 Grout into place.

Grade Rings as Required (12" maximum)

Grout Grade Ring into place

5.0'

12"

5' dia. Manhole

Washed Rock

Precast Concrete Perforated Manhole Section, Grout in Base.

6" min

Mirafix 140N Filter Fabric or approved equal

Gravel Bottom

Concrete Base 9" min. thickness Required

2 Typical Trench Detail
 Not to Scale

SECTION

Pavement: 3" min. asphalt and 8" min. road base or match existing thickness if greater.

Compacted Backfill

Saw Cut required clean and back coat edges.

Side slopes to conform with Local, State, and Federal OSHA requirements.

Sand and Gravel (2" minus Hard Wall Pipe, 3/4" Minus PVC Pipe)

Install pipe on stable foundation shape trench to fill bottom of pipe.

6" min. Sand or Gravel in unstable areas or through rock excavation Required.

3 Not to Scale

TYPICAL CULINARY WATER SERVICE CONNECTION

2" (OR 1 1/2") WATER METER STATION

1 1/2" & 2" WATER METER STATION

OWNERS RESPONSIBILITY:

- THE OWNER OR CONTRACTOR SHALL PAY CONNECTION FEE AND SECURE PERMITS.
- THE OWNER OR CONTRACTOR SHALL PAY FOR ALL COSTS OF INSTALLATION INCLUDING ALL MATERIALS, (SADDLE, NECESSARY PIPE, YOKE/SETTER, CHECK VALVE, METER ANGLE VALVE & EXPANSION METER BOX, CAST IRON RING & COVER, - METER PROVIDED BY BONA VISTA WATER DISTRICT) ALL EXCAVATION AND FILL, ASPHALT REPLACEMENT, WATER MAIN CONNECTION, AND LABORS.
- NOTIFY THE DISTRICT 24 HOURS IN ADVANCE FOR LINE LOCATIONS AND/OR TAP ON MAIN. ALL WORK MUST BE INSPECTED AND APPROVED BY BONA VISTA WATER DISTRICT.
- PROPER GRADE IS THE OWNERS/CONTRACTORS RESPONSIBILITY. THE DISTRICT WILL NOT SET METER UNLESS THE YOKE AND METER BOX ARE AT THE PROPER GRADE.
- WORK MAY BE DONE BY OWNER OR LICENSED PLUMBER OR CONTRACTOR. ALL WORK IS THE RESPONSIBILITY OF THE OWNER.
- OWNER OR CONTRACTOR SHALL CALL BLUE STAKES OR DIRECT TO UTILITY COMPANIES FOR LOCATION OF UNDERGROUND GAS, TELEPHONES, ELECTRIC, CABLE T.V., IRRIGATION, PETROLEUM, AND SEWER LINES BEFORE DIGGING.

DISTRICTS RESPONSIBILITY:

- BONA VISTA WATER DISTRICT WILL FURNISH AND INSTALL METER AT NO COST.
- THE DISTRICT WILL LOCATE WATER MAIN PRIOR TO EXCAVATION - 24 HOUR NOTICE.
- THE OWNER WILL MAKE THE TAP ON THE WATER MAIN ANGLE VALVE & EXPANSION METER BOX, CAST IRON RING & COVER, - METER PROVIDED BY BONA VISTA WATER DISTRICT) ALL EXCAVATION AND FILL, ASPHALT REPLACEMENT, WATER MAIN CONNECTION, AND LABORS.
- THE DISTRICT WILL FURNISH AND SET WATER METER IN CUSTOMERS YOKE.
- THE DISTRICT WILL INSPECT AND APPROVE ALL WORK - 24 HOUR NOTICE.

CONNECTION SCHEDULE

MATERIAL	SIZE	CONNECTION
STEEL AND/OR ASBESTOS CEMENT	1.5"	ROMAC TO 1"
STEEL AND/OR ASBESTOS CEMENT	1.5"	ROMAC TO 1" DOUBLE STRAP
CAST IRON AND/OR DUCTILE IRON	6"	CORPORATION STOP-MUELLER B-2502B
CAST IRON AND/OR DUCTILE IRON	6"	CORPORATION STOP-MUELLER B-2502B
PVC 8-3000	1.5"	CORPORATION STOP-MUELLER B-2502B
PVC 8-3000	1.5"	ROMAC TO 1" (FOR PVC) W/ L.R. CORPORATION STOP-MUELLER B-2502B
PVC 8-3000	1.5"	ROMAC TO 1" W/ L.R. STRAP (FOR PVC) W/ L.R. CORP. STOP-MUELLER B-2502B
PVC 8-3000	1.5"	ROMAC TO 1" W/ L.R. STRAP (FOR PVC) W/ L.R. CORP. STOP-MUELLER B-2502B
PVC 8-3000	1.5"	CONTROLLED G.B. SADDLE

① SADDLE CAN BE COMPARABLE TO ABOVE BUT SAME CORROSION PROOF BODY AND NICE STRAPS ARE REQUIRED.
 ② ALL NEW SUB CONNECTION TAPS SHALL BE DONE BY DEVELOPER. DISTRICT PROJECT TAPS SHALL BE COORDINATED BY THE DISTRICT.